


### SCHEDULE OF ELECTRICAL ITEMS

| POS      | Q.  | DESCRIPTION  | MODEL            | SUPPLIER      | ELI        | ECTRIC ISC | LATION PO                                 | DINT                  |
|----------|-----|--|------------------|---------------|------------|------------|---|-----------------------|
| . 00     | α.  | BEOGRIF HOR  | WODEL            | OOI I EIEIX   | POW. Kw    | VOLTAGE    | HEIGHT                                    | TYPE                  |
|          |     | 01-FOH   |                  |               |            |            |   |                       |
| F1       | 1   | THREE DOOR INTEGRAL UNDER COUNTER CHILLER GLASS DOORS                          | KGR18-3          | AONE MASTER   | 1.5        | 240        | 600                                       | E28                   |
| F2       | 1   | CASH REGISTER  | CASH REG         | BY CLIENT     | 2.4        | 240        | 700                                       | E25                   |
| F3       | 1   | WINE / BEER COOLER   | LIFE 100         | LANCER        | 2.4        | 240        | 500                                       | E26                   |
| F5       | 1   | SOFT SERVE ICE CREAM MACHINE   | TBA              | TBA           | 4.8        | 415        | 240 600 E28<br>240 700 E25<br>240 500 E26 |                       |
|          |     | 2-COOKING  |                  |               |            |            |   |                       |
| 10       | 1   | THREE DOOR INTEGRAL UNDER COUNTER CHILLER                                      | BC180-C-3RRRS-E  | SKOPE         | 0.9        | 240        | 600                                       | E28                   |
| 13       | 1   | 1/1GN SIZE BAIN MARIE  | WBMS11           | WOODSON       | 0.6        | 240        | 450                                       | E28                   |
| 14       | 1   | 1/1GN SIZE BAIN MARIE  | WBMS11           | WOODSON       | 0.6        | 240        | 450                                       | E28                   |
| 15       | 1   | ORDERING / BUMP SCREEN   | BUMP             | BY CLIENT     | 2.4        | 240        | 1500                                      | E25                   |
| 16       | 1   | TWO DOOR SANDWICH PREP CHILLER   | KHR12-2          | AONE MASTER   | 0.9        | 240        | 600                                       | E28                   |
| 18       | 1   | ORDERING / BUMP SCEEN  | BUMP             | BY CLIENT     | 2.4        | 240        | 2700                                      | E25                   |
| 19       | 1   | RICE DISPENSER   | GST-FBB-CE       | SUZUMO        | 0.4        | 240        | 500                                       | E26                   |
| 20       | 1   | HOLD HOLDING BINS - 4 PANS   | DHB2SS-20        | FSM           | 0.9        |            |   |                       |
| 21       | 1   | HOLD HOLDING BINS - 4 PANS   | DHB2SS-20        | FSM           | 0.9        |            |   |                       |
| 22       | 1   | HEAVY DUTY MICROWAVE OVEN 1400 WATT  | CM-1401T         | FSM           | 2.4        |            |   |                       |
| 23       | 1   | FAST COOKING OVEN  | SOTA             | TURBOCHEF     | 6.2        |            |   |                       |
| 24       | 1   | FAST COOKING OVEN  | SOTA             | TURBOCHEF     | 6.2        |            |   |                       |
| 29       | 1   | REFRIGERATED PIZZA PREP TABLE  | MBPT67           | TURBO AIR     | 0.9        |            |   |                       |
| 30       | 1   | ORDERING / BUMP SCREEN   | BUMP             | BY CLIENT     | 2.4        |            |   |                       |
| 31       | 1   | ORDERING / BUMP SCREEN   | BUMP             | BY CLIENT     | 2.4        |            |   |                       |
| 33       | 1   | TWIN COMPUTER GAS FRYER - WITH FILTER SYSTEM                                   | SSH55            | PITCO         | 2.4        |            |   |                       |
| 35<br>36 | 1 1 | VARIABLE TEMP REFRIGERATION COMPACT DRAWER HEAVY DUTY MICROWAVE OVEN 1400 WATT | VCC1<br>CM-1401T | ADANDE<br>FSM | 0.9<br>2.4 |            |   |                       |
| 37       | 1   | GYOZA COOKER   | GS-2STR-N        | BY CLIENT     | 3.9        |            |   |                       |
| 40       | 1   | ORDERING / BUMP SCREEN   | BUMP             | BY CLIENT     | 2.4        |            |   |                       |
| 41       | 1   | 1/1GN SIZE BAIN MARIE  | WBMS11           | WOODSON       | 0.6        |            |   |                       |
| 47       | 1   | ST/STEEL WALL MOUNTED HOOD - LIGHTING CIRCUIT                                  | CUSTOM           | CUSTOM        | 0.3        |            |   |                       |
| .,       |     | 3-WASH UP  | 33070111         |               | 0.0        |            | 2.00                                      |                       |
| 60       | 1   | PASS THROUGH DISHWASHER WITH HEAT RECOVERY                                     | ALC              | MOFFAT        | 10         | 415        | 600                                       | E34                   |
| 63       | 1   | ELECTRIC QUICK RECOVERY HOT WATER SYSTEM                                       | QRHWS            | BY PLUMBER    | REFE       | R TO PLUMB | ER FOR DE                                 | ΓAILS                 |
|          |     | 4-BOH  |                  |               |            |            |   |                       |
| 70       | 1   | 2 DOOR UPRIGHT CHILLER, SOLID DOOR - RE-USE                                    | RE-USE           | BY CLIENT     | 1          | 240        | 2200                                      | E28                   |
| 71       | 1   | 2 DOOR UPRIGHT CHILLER, SOLID DOOR - RE-USE                                    | RE-USE           | BY CLIENT     | 1          | 240        | 2200                                      | E28                   |
| 72       | 1   | 2 DOOR UPRIGHT FREEZER, SOLID DOOR - RE-USE                                    | RE-USE           | BY CLIENT     | 1.8        | 240        | 2200                                      | E28                   |
| 81       | 1   | OIL FILTRATION SYSTEM  | COOKERS200LT     | BY CLIENT     | 1.5        | 240        | MOBILE                                    | EQUIPMEN              |
| 82       | 1   | OIL FILTRATION SYSTEM  | COOKERS200LT     | BY CLIENT     | 1.5        | 240        | MOBILE                                    | EQUIPMEN <sup>*</sup> |

### INSTALLATION EXAMPLES REFER TO TYPE COLUMN ABOVE

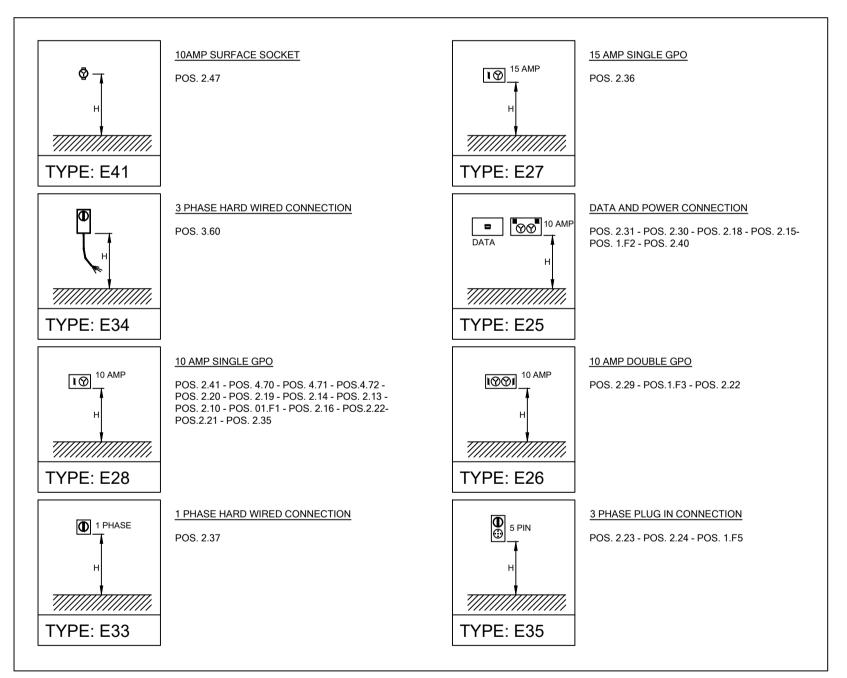

### **GENERAL ELECTRICAL NOTES**

- 1. Installation and materials shall be in accordance with Australian standards and any other local standards/codes.
- 2. Electrician to supply and fit all GPO (general purpose outlets) as nominated on electrical drawings. Position of GPOs are not indicated for plug in equipment. Electrician to consult site project manager before locating. Electrician to supply and install all . switches with stainless steel face plates where possible. Works also include the fitting of GPOs to cut-outs in benches and equipment provided by the stainless steel contractor.
- 3. Electrician to supply and fit all necessary contactors, starters, circuit breakers and multi phase isolators for equipment as nominated on electrical drawings. Works also include the connecting of cable/conduit from the isolator to the equipment terminals.
- 4. Electrician to connect all hard wired equipment as nominated on electrical drawings. Symbol positions indicated on the equipment may be the conduit entry points or terminal block connection points of control panels, not recommended isolator switch positions. Any direct connection works are also to include connection of cable/conduit from the main switchboard or lighting circuit to the connection point.
- 5. Electrician to interwire condensing units with evaporator coils in walk in coldroom/freezer rooms
- 6. Electrician to interwire light fixtures in walk in coldroom/freezer rooms. Conduit to run on exterior (above) where possible.
- 7. Electrician to supply and install start/stop switch with red light indicator for exhaust and return air fans (unless provided in hood) located over cooking equipment (duct and fan to be supplied by
- 8. Electrician to connect hood lights in exhaust and to supply and install wall switch (unless provided in hood).
- 9. Electrician to supply and install start/stop switch for condensate exhaust air fans located over dishwashing machines (duct and fan to be supplied by others).
- 10. Electrician is responsible for all final connections, testing of all switch gear and wiring.
- 11. Exposed flexible ripple conduits are not permitted in food and beverage areas. Conduit to be smooth finish (either flexible or solid round) and to be mounted a minimum of 25mm off the wall using stand off brackets. "AussieDuct" may be used but must be flush mounted without any gaps (a silicone sealant may be required at edges).
- 12. All lighting must comply with AS1680.
- 13. All appliances are to have on/off isolation switches.
- 14. Any electrical wiring connections coming from the floor must be water proofed.
- 15. Upgrade switchboard as required install safety switch.
- 16. Provide light and power from switchboard to all positions nominated.
- 17. The electrical sketches shown are a guideline for the electrical contractor only. It is the electrical contractor's responsibility to foresee any installation issues and rectify or report.

NOTE: Dimensions indicated on the drawing are provided for rough in purposes only. Electrician must coordinate the site and the requirements of the final connection points of the equipment.

### FOOD PREMISES DESIGN

### **PROJECT** MOTTO MOTTO

### **ADDRESS**

**ROBINA TOWN CENTRE ROBINA PARKWAY** ROBINA QLD 4226

### CLIENT ZERO 9 / MOTTO MOTTO

DATE **DRAWN BY** 

14/08/2021 AF

**DRAWING NAME** KITCHEN ELECTRICAL ISOLATION POINTS

DWG NO. **ISSUE NO.** MMR-07 (DT.SER)

**SCALE** 1:50 on A3

0 02/08/2021 KITCHEN FLOOR PLAN FOR **DISCUSSION AND REVIEW** 

A 14/08/2021 KITCHEN DESIGN FOR COUNCIL FOOD PREMISES **DESIGN SUBMISSION** 



7/1147 Southpine Road, Arana Hills Q 4054 Ph: 07 3855 9956 Fax: 3337 9817 Mob: 0432 088 237

sales@fire-ice.com.au | www.fire-ice.com.au

Do not scale from drawings. All dimensions are to be checked on site prior to commencing work. Report any discrepancies to the author.


**ELECTRONIC DRAWINGS** Electronic drawings are controlled documents and are issued for information only. Any dimensions not nominated must be referred to the Fire & Ice for confirmation.

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ELECTRICAL ISOLATION POINTS OF CONNECTION

### ELECTRICAL LEGEND 10 amp GPO. Install at height as shown on schedule 3Ph direct electric connection. Hard connect to unit. Dual 10 amp GPD. Install at height as shown on schedule Mount isolator at height as shown on schedule 15 amp GPD. Install at height as shown on schedule Electrical access penetration from floor for cabling in 20 amp GPD. Install at height as shown on schedule Electrical access penetration from ceiling for cabling in island situations 10 amp H/Duty GPO. Install at height as shown on schedule 2 phase switch socket for plug-in. Supply lead & plug if req. 10 or 15 amp pendant outlet hanging from ceiling Refer electrical rating as nominated on schedule Install at height as shown on schedule 3 phase switch socket for plug-in Supply lead & plug if req. Electrical emergemcy stop switch. Install at height as shown on schedule Install at height as shown on schedule 10 amp GPO and data point for cash register, dedicated circuit Electrical switch board. Refer to electrical engineering drawings Refer for details of location and installation 1Ph direct electric connection. Hard connect to unit. Mount isolator at height as shown on schedule DO NOT CUT HOLES IN EQUIPMENT OR BENCHES FOR SWITCHES OR GPD's 2Ph direct electric connection. Hard connect to unit. HOLES SHOULD BE CUT BY THE ST/STEEL CONTRACTOR UPON REQUEST REFER TO INSTALLATION EXAMPLE DRAWINGS FOR GUIDE ON INSTALLATION IDEA PROPOSED. HOWEVER ELECTRICIAN TO DETERMINE BEST SOLUTION ON SITE. Mount isolator at height as shown on schedule




### SCHEDULE OF GAS ITEMS - REFER TO SPEC BOOK FOR FURTHER EQUIPMENT DETAILS
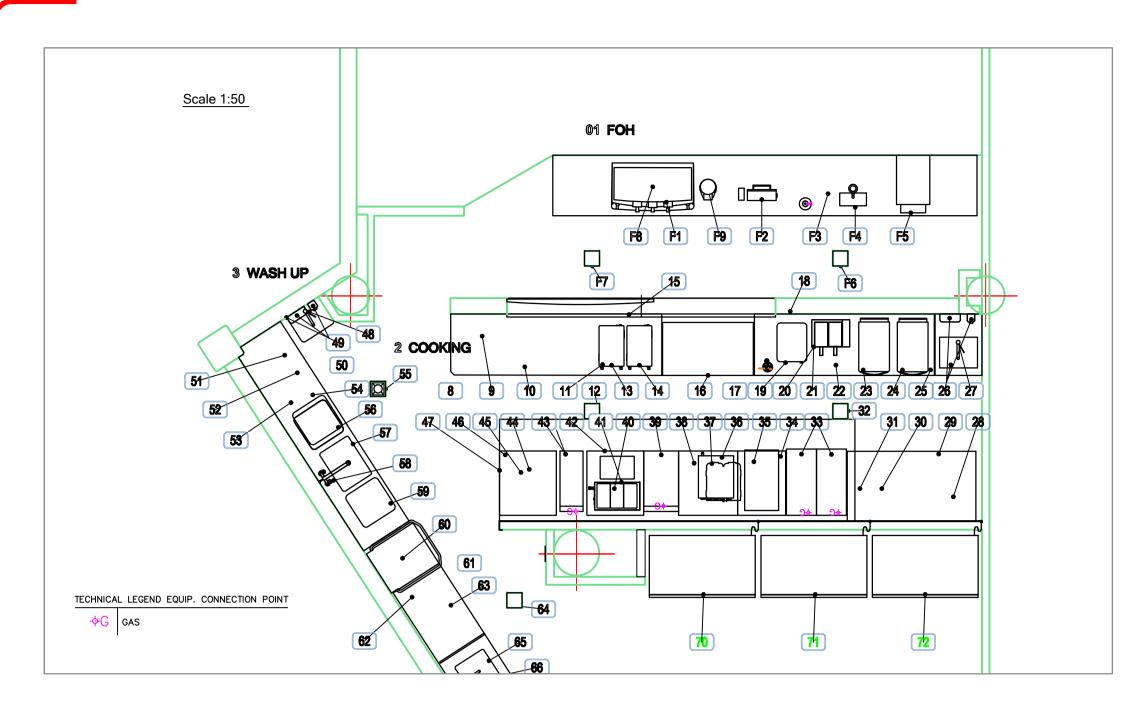
| POS |    | DESCRIPTION                                  | MODEL         | SUPPLIER | GAS     |       |        |         |  |  |
|-----|----|--|---------------|----------|---------|-------|--------|---------|--|--|
| FU3 | Q. |  | MODEL         | SUPPLIER | POW. MJ | DIAM. | HEIGHT | TYPE    |  |  |
|     |    | 2-COOKING                                    |               |          |         |       |        |         |  |  |
| 33  | 1  | TWIN COMPUTER GAS FRYER - WITH FILTER SYSTEM | SSH55-C-FF-FD | PITCO    | 170     | 3/4"  | 267    | NAT GAS |  |  |
| 39  | 1  | NOODLE COOKER                                | NC-6          | B&S      | 59      | 3/4"  | 150    | NAT GAS |  |  |
| 43  | 1  | 2 BURNER GAS COOK TOP ON STAND               | PFB-12        | MIDDLEBY | 52      | 3/4"  | 21     | NAT GAS |  |  |
| 44  | 1  | RICE COOKER 50 CUP                           | RER55A        | RINNAI   | 36      | 1/2"  | 50     | NAT GAS |  |  |
| 45  | 1  | RICE COOKER 50 CUP                           | RER55AS       | RINNAI   | 36      | 1/2"  | 50     | NAT GAS |  |  |

PLEASE NOTE: THE POINTS SHOWN ON THE PLAN ARE THE CONNECTION POINTS OF THE FIXTURES (GAS CONNECTION POINTS) THE GAS FITTER / HYDRAULIC CONSULTANT WILL NEED TO ALLOW ANY REQUIRED OFFSETS FOR THEIR PENETRATIONS FOR THE GAS SYSTEM OR PLACEMENT OF GAS STOP COCKS SO AS THEY DO NOT STAND EQUIPMENT OFF THE WALL BY BEING DIRECTLY BEHIND THEM.

### **GENERAL GAS NOTES**


- Installation and materials shall be in accordance with Australian standards and any other local standards/codes.
- The plumber/gas fitter shall allow to make all necessary applications to authorities for approval of works and pay all associated appropriate fees/charges (unless otherwise agreed with client prior to commencement of works).
- The plumber/gas fitter shall coordinate and confirm all proposed pipe routes, equipment service requirements and location suitability with all relevant parties prior to conducting the works.
- 4. The plumber/gas fitter is responsible for all interconnecting and final connections and testing, including the supply and fitting of all stopcocks and taps required for all equipment.
- 5. In the case of fire extinguising systems being installed, shut off valves are to be installed in main gas lines. It is the responsibility of the plumber/gas fitter to coordinate these works with the fire services contractor.
- 6. The plumber/gas fitter is to check that appliances are set to function on the correct gas type.
- 7. The plumber/gas fitter is to check all manifold connections, hoses and cooking equipment for leaks.
- 8. The plumbing/gas sketches shown are a guideline for the plumber/gas fitter only. It is the plumber/gas fitter's responsibility to foresee any installation issues and rectify or report.

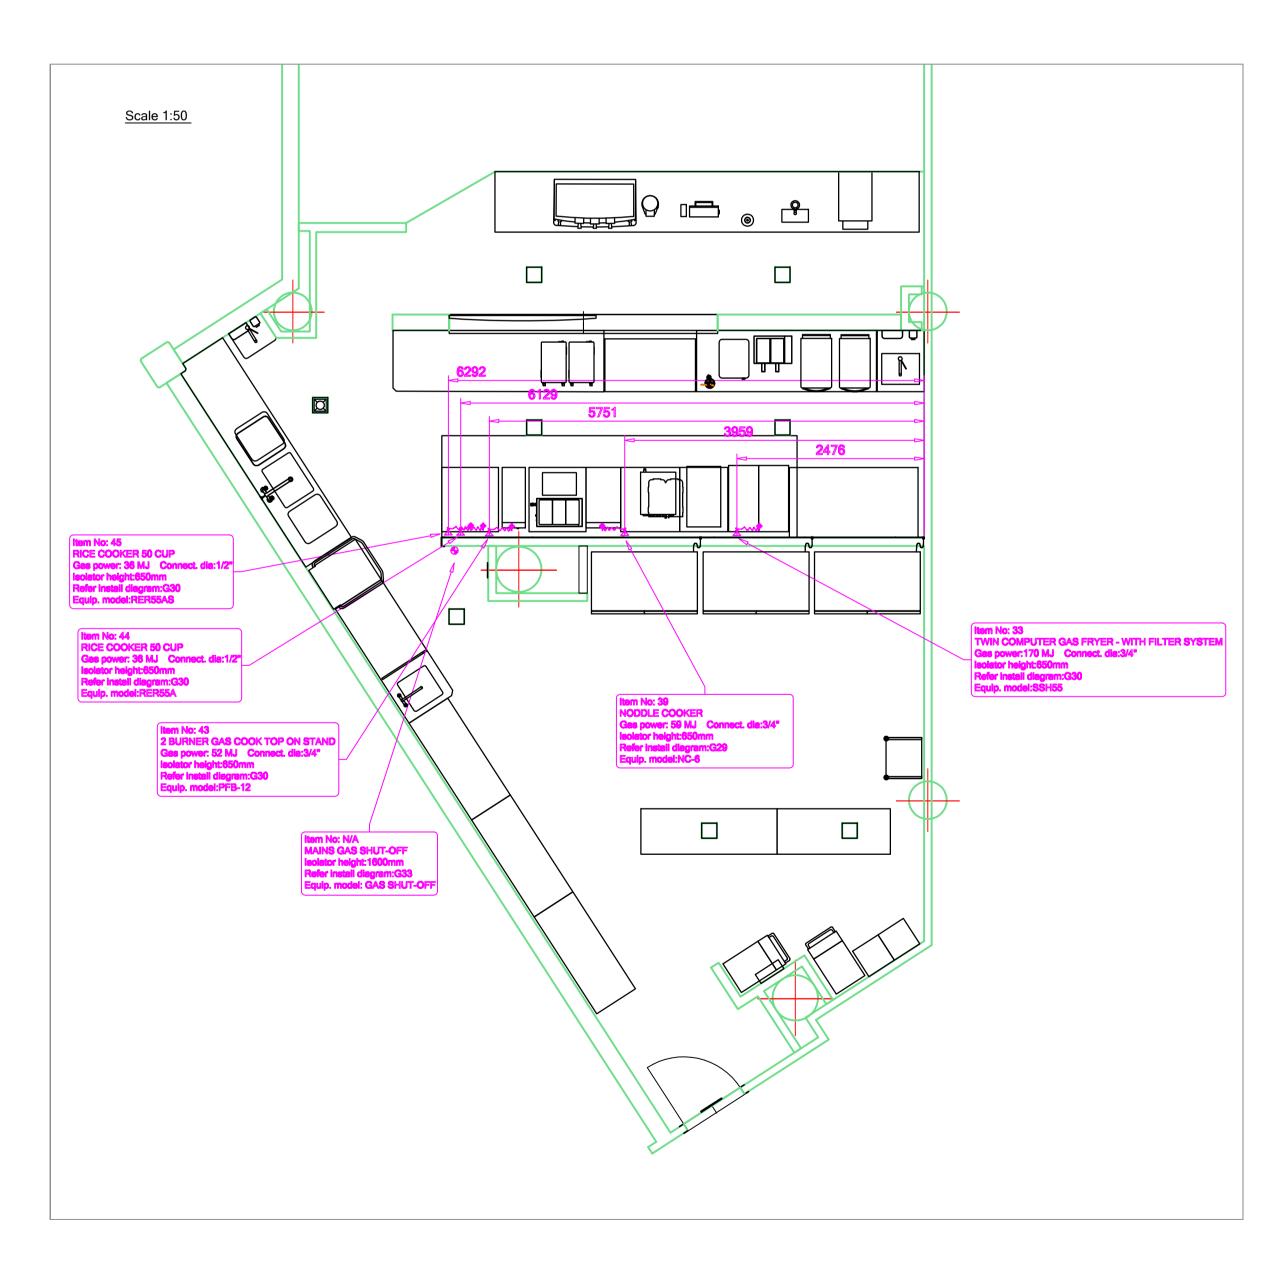

### SCHEDULE OF GAS ISOLATION POINTS

| POS | Q. | . DESCRIPTION                                | MODEL   | SUPPLIER | GAS ISOLATION POINTS |       |        |      |  |
|-----|----|--|---------|----------|----------------------|-------|--------|------|--|
| -03 | Q. | DESCRIPTION                                  |         |          | POW. MJ              | DIAM. | HEIGHT | TYPE |  |
|     |    | 2-COOKING                                    |         |          |                      |       |        |      |  |
| 33  | 1  | TWIN COMPUTER GAS FRYER - WITH FILTER SYSTEM | SSH55   | PITCO    | 170                  | 3/4"  | 650    | G30  |  |
| 39  | 1  | NODDLE COOKER                                | NC-6    | B&S      | 59                   | 3/4"  | 650    | G29  |  |
| 43  | 1  | 2 BURNER GAS COOK TOP ON STAND               | PFB-12  | MIDDLEBY | 52                   | 3/4"  | 650    | G30  |  |
| 44  | 1  | RICE COOKER 50 CUP                           | RER55A  | RINNAI   | 36                   | 1/2"  | 650    | G30  |  |
| 45  | 1  | RICE COOKER 50 CUP                           | RER55AS | RINNAI   | 36                   | 1/2"  | 650    | G30  |  |
|     |    |  |         |          |                      |       |        |      |  |

### INSTALLATION EXAMPLES REFER TO TYPE COLUMN ABOVE

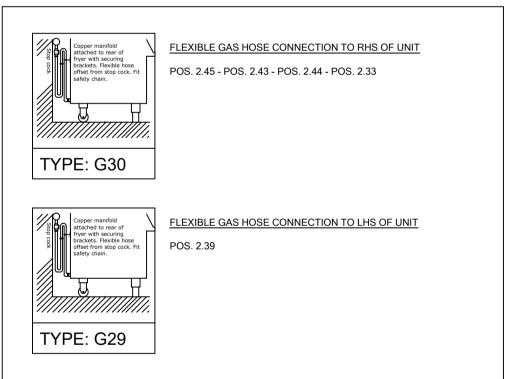

### FOOD PREMISES DESIGN

# PROJECT MOTTO MOTTO

### **ADDRESS**

ROBINA TOWN CENTRE ROBINA PARKWAY ROBINA QLD 4226

### **CLIENT**

## ZERO 9 / MOTTO MOTTO

DATE DRAWN BY

14/08/2021 AF

DRAWING NAME
KITCHEN GAS
ISOLATION POINTS

DWG NO. ISSUE NO.

MMR-08

SCALE

1:50 on A3

0 02/08/2021 KITCHEN FLOOR PLAN FOR DISCUSSION AND REVIEW

A 14/08/2021 KITCHEN DESIGN FOR COUNCIL FOOD PREMISES

DESIGN SUBMISSION



7/1147 Southpine Road, Arana Hills Q 4054 Ph: 07 3855 9956 Fax: 3337 9817 Mob: 0432 088 237 sales@fire-ice.com.au | www.fire-ice.com.au

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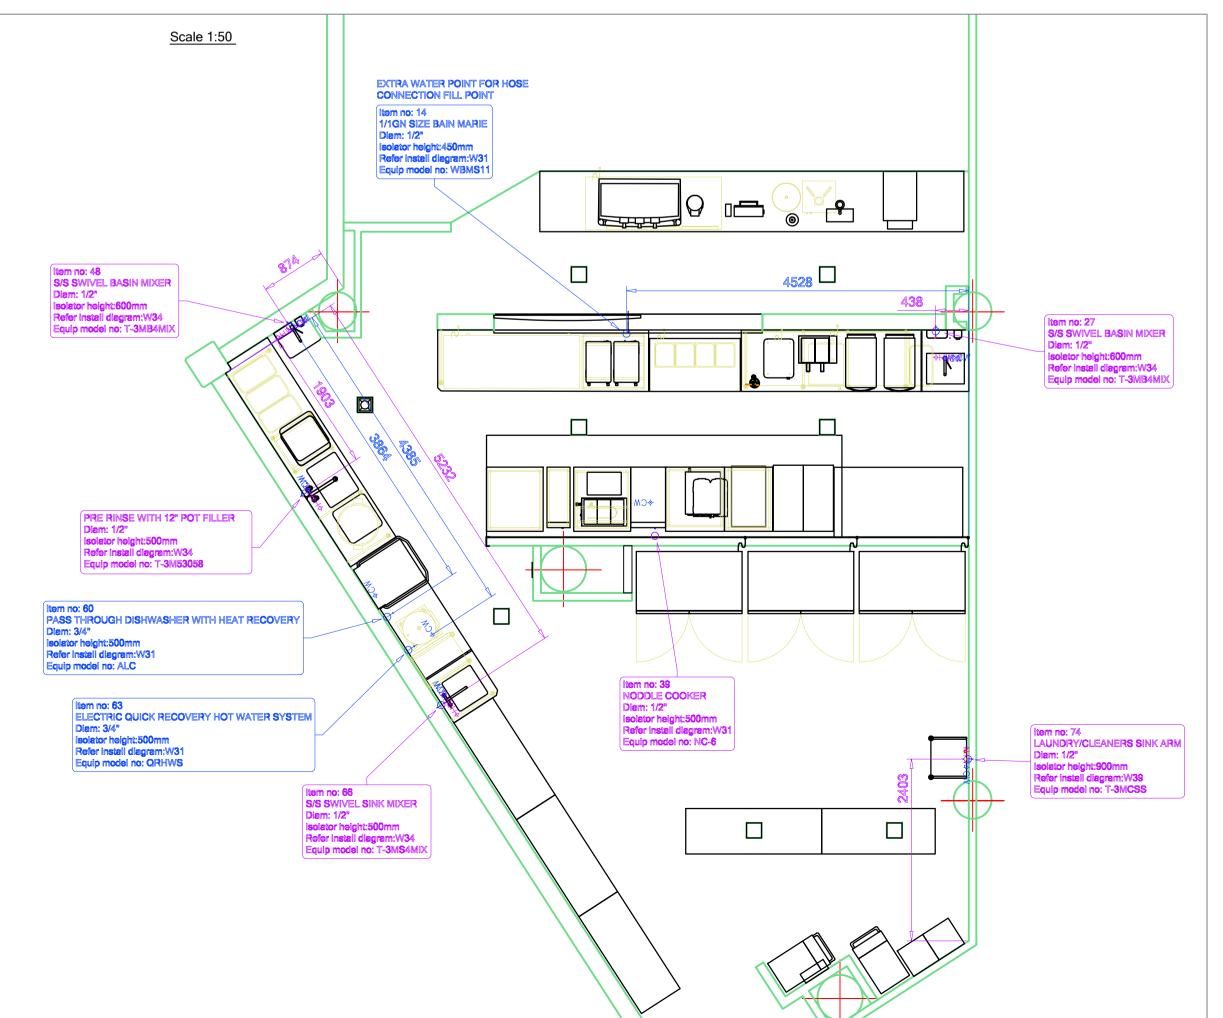
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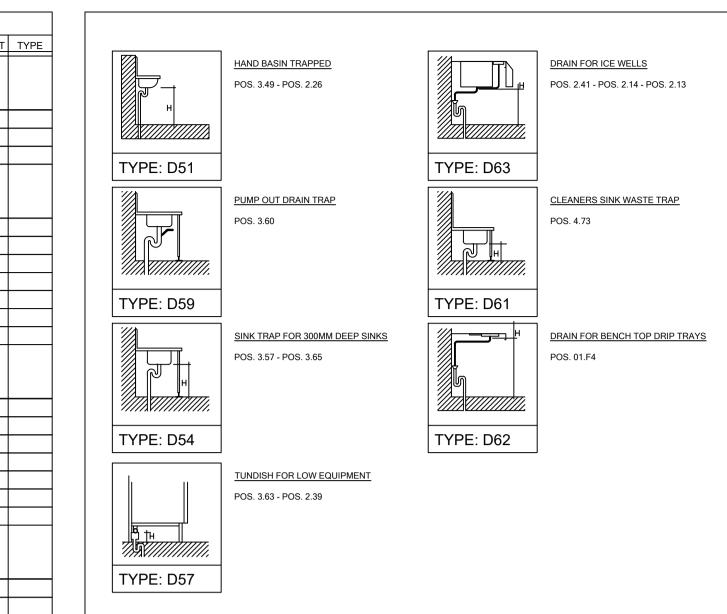
### WATER ISOLATION POINTS



### SCHEDULE OF DRAIN ISOLATION POINTS

| POS Q. |    | DESCRIPTION                                   | MODEL        | SUPPLIER   |       | DRAIN  | I ISOLA | SOLATION POINTS |        |      |  |  |
|--------|----|---|--------------|------------|-------|--------|---------|-----------------|--------|------|--|--|
| 103    | α. | DESCRIPTION                                   | WODEL        | SOFFLIER   | DIAM. | HEIGHT | TYPE    | DIAM.           | HEIGHT | TYPE |  |  |
|        |    | 01-FOH  |              |            |       |        |         |                 |        |      |  |  |
| F4     | 1  | SINGLE COLUMN BEER FAUCET                     | BEER-1       | BY BEER CO | 25mm  | 850    | D62     |                 |        |      |  |  |
| F6     | 1  | 200MM SQUARE FLOOR WASTE WITH BUCKET TRAP 304 | FW-200BS-304 | 3MONKEEZ   |       |        |         |                 |        |      |  |  |
| F7     | 1  | 200MM SQUARE FLOOR WASTE WITH BUCKET TRAP 304 | FW-200BS-304 | 3MONKEEZ   |       |        |         |                 |        |      |  |  |
|        |    | 2-COOKING                                     |              |            |       |        |         |                 |        |      |  |  |
| 12     | 1  | 200MM SQUARE FLOOR WASTE WITH BUCKET TRAP 304 | FW-200BS-304 | 3MONKEEZ   |       |        |         |                 |        |      |  |  |
| 13     | 1  | 1/1GN SIZE BAIN MARIE                         | WBMS11       | WOODSON    | 50mm  | 500    | D63     |                 |        |      |  |  |
| 14     | 1  | 1/1GN SIZE BAIN MARIE                         | WBMS11       | WOODSON    | 50mm  | 500    | D63     |                 |        |      |  |  |
| 26     | 1  | INSET HAND BASIN                              | HBF-1        | 3MONKEEZ   | 40mm  | 760    | D51     |                 |        |      |  |  |
| 32     | 1  | 200MM SQUARE FLOOR WASTE WITH BUCKET TRAP 304 | FW-200BS-304 | 3MONKEEZ   |       |        |         |                 |        |      |  |  |
| 39     | 1  | NODDLE COOKER                                 | NC-6         | B&S        | 50mm  | 150    | D57     |                 |        |      |  |  |
| 41     | 1  | 1/1GN SIZE BAIN MARIE                         | WBMS11       | WOODSON    | 25mm  | 500    | D63     |                 |        |      |  |  |
|        |    | 3-WASH UP                                     |              |            |       |        |         |                 |        |      |  |  |
| 49     | 1  | HAND BASIN WITH 300MM SPLASHBACK              | HB300SB      | 3MONKEEZ   | 40mm  | 760    | D51     |                 |        |      |  |  |
| 55     | 1  | 200MM SQUARE FLOOR WASTE WITH BUCKET TRAP 304 | FW-200BS-304 | 3MONKEEZ   |       |        |         |                 |        |      |  |  |
| 57     | 1  | SINK BOWL FOR WELDING INTO BENCHES            | HF19         | 3MONKEEZ   | 50mm  | 600    | D54     |                 |        |      |  |  |
| 60     | 1  | PASS THROUGH DISHWASHER WITH HEAT RECOVERY    | ALC          | MOFFAT     | 25mm  | 350    | D59     |                 |        |      |  |  |
| 63     | 1  | ELECTRIC QUICK RECOVERY HOT WATER SYSTEM      | QRHWS        | BY PLUMBER | 25mm  | 150    | D57     |                 |        |      |  |  |
| 64     | 1  | 200MM SQUARE FLOOR WASTE WITH BUCKET TRAP 304 | FW-200BS-304 | 3MONKEEZ   |       |        |         |                 |        |      |  |  |
| 65     | 1  | SINK BOWL FOR WELDING INTO BENCHES            | HF17         | 3MONKEEZ   | 50mm  | 600    | D54     |                 |        |      |  |  |
|        |    | 4-BOH   |              |            |       |        |         |                 |        |      |  |  |
| 73     | 1  | CLEANERS SINK WITH GRATE AND ADJUSTABLE LEGS  | AB-CS-L-500  | 3MONKEEZ   | 50mm  | 320    | D61     |                 |        |      |  |  |
| 75     | 1  | 200MM SQUARE FLOOR WASTE WITH BUCKET TRAP 304 | FW-200BS-304 | 3MONKEEZ   |       |        |         |                 |        |      |  |  |
| 76     | 1  | 200MM SQUARE FLOOR WASTE WITH BUCKET TRAP 304 | FW-200BS-304 | 3MONKEEZ   |       |        |         |                 |        |      |  |  |

### INSTALLATION EXAMPLES REFER TO TYPE COLUMN ADJACENT




### PLUMBING ISOLATION POINTS OF CONNECTION

| HYDRAULIC LEGEND  | <u> </u>  |
|---|---|
| Sink waste or direct equipment connection point suggested position of penetration through floor with allowance made for trap swing  | Refrigeration lines- provide 50mm penetration   |
| Sink waste with food catching bucket trap waste suggested position of penetration through floor   | ¥   |
| with allowance made for trap swing  | Beer lines conduit non-direct run - provide 250mm penetration   |
| -(w)- Floor waste - complete with bucket trap   | -PM- Post mix lines conduit straight run - provide 150mm penetration  |
| Tundish for equipment or condensate discharge, plumbing sub-contractor to connect from unit to tundish  | Post mix lines conduit non-direct run - provide 250mm penetration   |
| Floor trough/gully waste with bucket trap   |   |
| Hot water isolation point. Plumber to connect to fixture  | St Steam isolation point - Fitter to connect to fixture   |
| Cold water isolation point. Plumber to connect to fixture   | <u>NOTES:</u> FLOOR WASTE POSITIONS ARE INDICATIVE ONLY, REFER TO   |
| Cold water & Filter isolation point. Plumber to connect to fixture  | HYDRAULICS CONSULTANTS DRAWINGS FOR ACTUAL LOCATIONS.  SERVICES SHOWN ARE SUGGESTED FINAL CONNECTION POINTS ONLY- PENETRATIONS TO BE CHECKED FOR SUITABILITY ON SITE BY OTHERS. |
| Hot & cold water isolations (combination). Plumber to connect Sink units - high swivel tapset- hose cocks from wall 500 affl. Pre rinse - hose cocks- wall mount 500ab.ffl. | DO NOT CUT HOLES IN EQUIPMENT OR BENCHES UNLESS IT HAS BEEN CHECKED CHECKED WITH THE SUPPLIER OR ST/STEEL CONTRACTOR FIRST  |
| Hand basin - swivel tapset- hose cocks from wall 600 affl.  Fit electronic operated tap if required specified   | REFER TO INSTALLATION EXAMPLE DRAWINGS FOR GUIDE ON INSTALLATION IDEA PROPOSED. HOWEVER PLUMBER SHOULD DETERMINE BEST SOLUTION ON SITE  |


### SCHEDULE OF WATER ISOLATION POINTS

| POS | Q. | DESCRIPTION                                      | MODEL     | CLIDDLIED  | HOT WATER ISOALTOR   COLD WATER ISO |        |      |       |        |      |
|-----|----|--|-----------|------------|-------------------------------------|--------|------|-------|--------|------|
| -03 |    |  | MODEL     | SUPPLIER   | DIAM.                               | HEIGHT | TYPE | DIAM. | HEIGHT | TYPE |
|     |    | 2-COOKING  |           |            |                                     |        |      |       |        |      |
| 14  | 1  | 1/1GN SIZE BAIN MARIE                            | WBMS11    | WOODSON    |                                     |        |      | 1/2"  | 450    | W31  |
| 27  | 1  | S/S SWIVEL BASIN MIXER                           | T-3MB4MIX | 3MONKEEZ   | 1/2"                                | 600    | W34  |       |        |      |
| 39  | 1  | NODDLE COOKER                                    | NC-6      | B&S        | 1/2"                                | 500    | W31  |       |        |      |
|     |    | 3-WASH UP  |           |            |                                     |        |      | T     |        |      |
| 48  | 1  | S/S SWIVEL BASIN MIXER                           | T-3MB4MIX | 3MONKEEZ   | 1/2"                                | 600    | W34  |       |        |      |
| 58  | 1  | S/S DUAL HOB MOUNT PRE RINSE WITH 12" POT FILLER | T-3M53058 | 3MONKEEZ   | 1/2"                                | 500    | W34  |       |        |      |
| 60  | 1  | PASS THROUGH DISHWASHER WITH HEAT RECOVERY       | ALC       | MOFFAT     |                                     |        |      | 3/4"  | 500    | W31  |
| 63  | 1  | ELECTRIC QUICK RECOVERY HOT WATER SYSTEM         | QRHWS     | BY PLUMBER |                                     |        |      | 3/4"  | 500    | W31  |
| 66  | 1  | S/S SWIVEL SINK MIXER                            | T-3MS4MIX | 3MONKEEZ   | 1/2"                                | 500    | W34  |       |        |      |
|     |    | 4-BOH  |           |            |                                     |        |      |       |        |      |
|     |    | LAUNDRY/CLEANERS SINK ARM                        | T-3MCSS   | 3MONKEEZ   | 1/2"                                | 900    | W39  |       |        |      |


### INSTALLATION EXAMPLES REFER TO TYPE COLUMN ABOVE

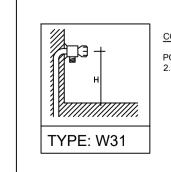

COLD & HOT WATER FOR EQUIPMENT
POS. 2.14 - POS. 3.60 - POS. 3.63 - POS. 2.39

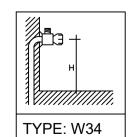

HOT & COLD WATER FOR SINK MIXERS
POS. 3.48 - POS. 3.58 - POS. 3.66 - POS. 2.27

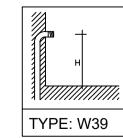

HOT & COLD WATER FOR CLEANER SINK TAPS
POS. 4.74

FOOD PREMISES DESIGN

PROJECT
MOTTO MOTTO

**ADDRESS** 

ROBINA TOWN CENTRE ROBINA PARKWAY ROBINA QLD 4226

**CLIENT** 

### ZERO 9 / MOTTO MOTTO

DATE DRAWN BY

AF

DRAWING NAME

14/08/2021

KITCHEN PLUMBING ISOLATION POINTS

DWG NO. ISSUE NO.

MMR-09 (DT.SER)

scale 1:50 on A1

0 02/08/2021 KITCHEN FLOOR PLAN FOR DISCUSSION AND REVIEW

A 14/09/2021 MITCHEN DECICAL FOR

A 14/08/2021 KITCHEN DESIGN FOR COUNCIL FOOD PREMISES DESIGN SUBMISSION



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DISCLAIMER
Do not scale from drawings. All dimensions are to be checked on site prior to commencing work. Report any discrepancies to the author.

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